

**FLORIDA DEPARTMENT OF
TRANSPORTATION**




ATTACHMENTS

ITB-DOT-14/15-8005-GB


INSTALLATION OF FENCE AND CANTILEVER SLIDE SECURITY GATE

FLORIDA'S TURNPIKE (S.R. 91), MILEPOST 99.0


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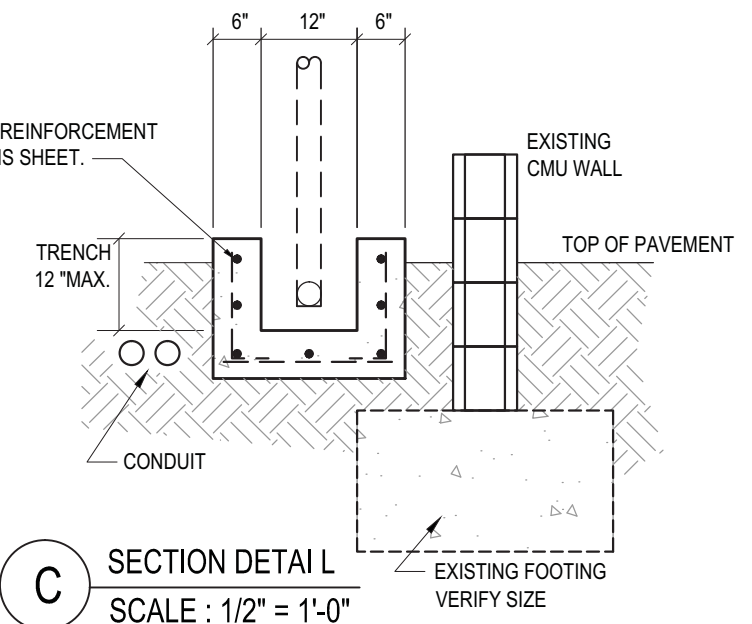
1 SECURITY GATE PARTIAL PLAN
 SCALE : 3/16" = 1'-0"

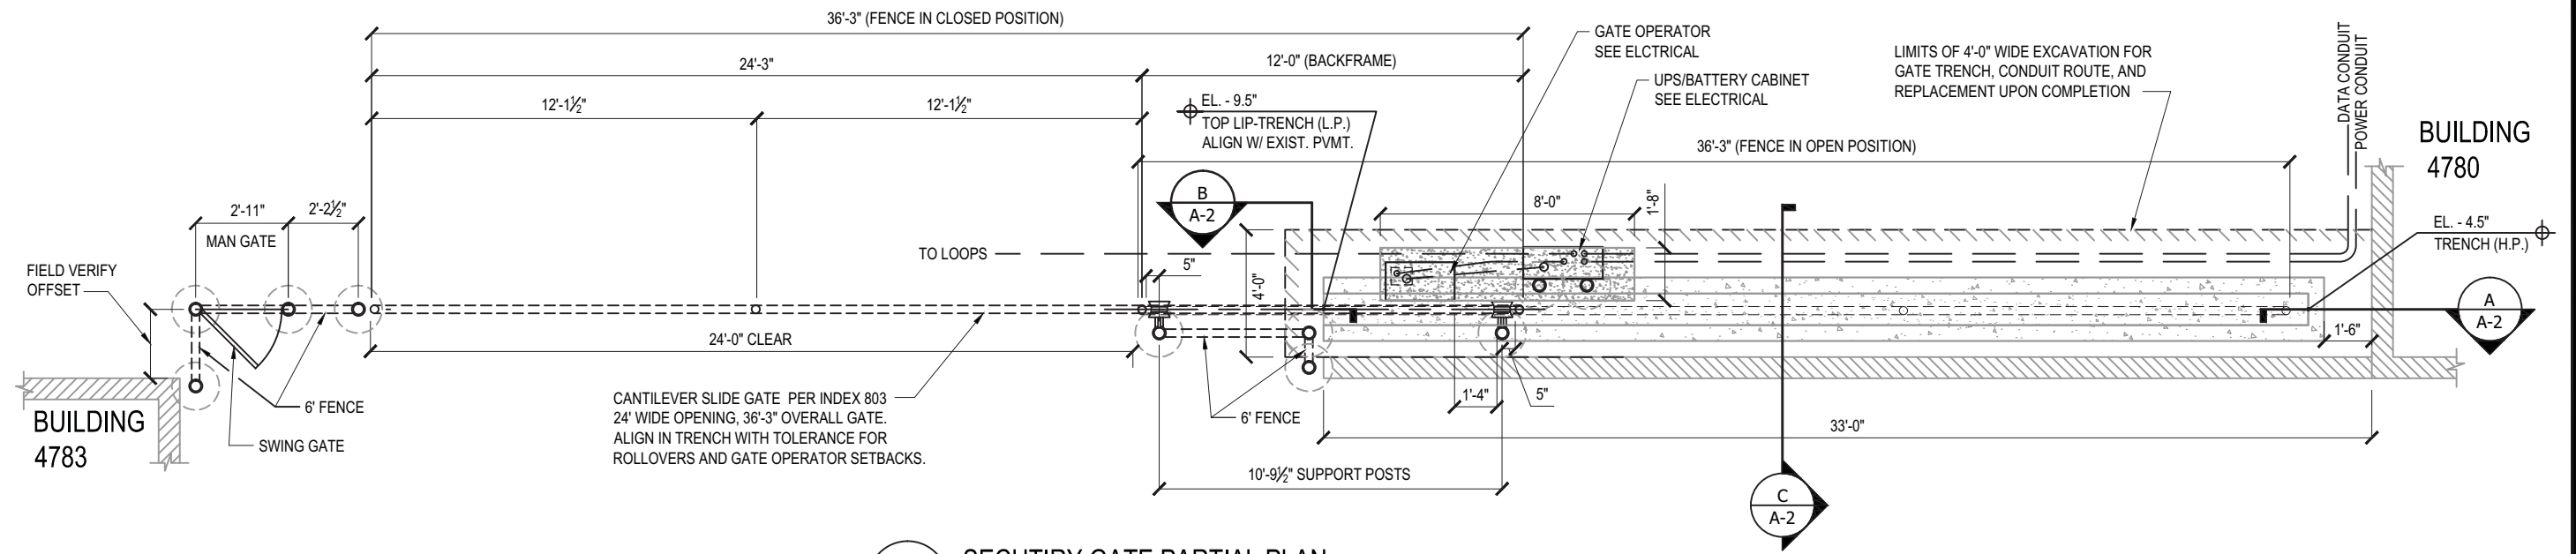


A SECTION DETAIL L
 SCALE : 1/2" = 1'-0"

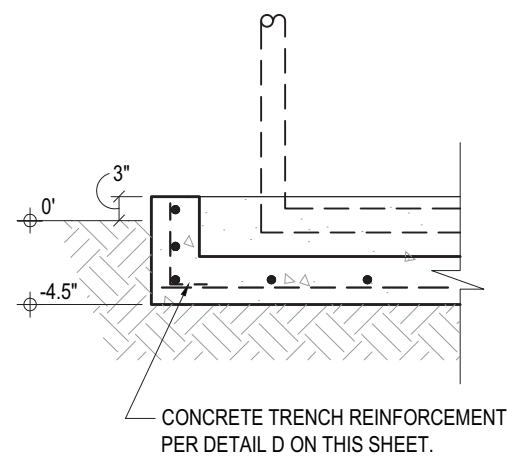

B SECTION DETAIL L
 SCALE : 1/2" = 1'-0"

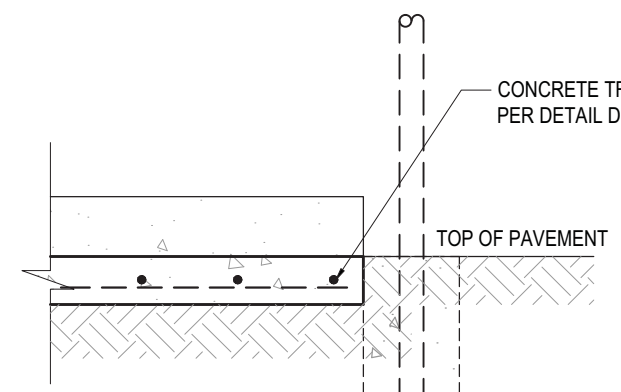

C SECTION DETAIL L
 SCALE : 1/2" = 1'-0"

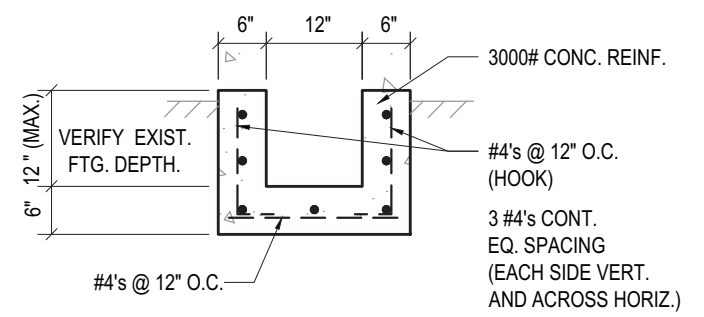

D TRENCH REINFORCEMENT DETAIL
 SCALE : 1/2" = 1'-0"

JEFFREY WARMINGTON, AIA.
 R.A. LICENSE No.: 13828

REVISIONS						ATKINS 2001 NW 107th Avenue Miami, FL 33172-2507 Certificate of Authorization No. AA 000723	STATE OF FLORIDA DEPARTMENT OF TRANSPORTATION			ELECTRONIC SECURITY GATE CENTRAL REPAIR DEPOT- MP99 SECURITY GATE PARTIAL PLAN & DETAILS	SHEET NO.
DATE	BY	DESCRIPTION	DATE	BY	DESCRIPTION		ROAD NO.	COUNTY	FINANCIAL PROJECT ID		A-2
								WEST PALM BEACH			


FENCE NOTES:

NOTES APPLICABLE TO THIS PROJECT:

1. SPECIFICATIONS GOVERNING THE FENCING IS SECTION 550 OF THE FLORIDA DEPARTMENT OF TRANSPORTATION STANDARD SPECIFICATIONS FOR ROAD AND BRIDGE CONSTRUCTION 2010 EDITION AND INDEXES 802 AND 803 OF THE 2010 FDOT DESIGN STANDARDS
2. THE FENCE LINE COMPONENT OPTIONS AS NOTED IN INDEX 802 OF THE 2010 FDOT DESIGN STANDARDS, PAGE 1 OF 3 THAT HAVE BEEN SELECTED ARE:
 - A. LINE POST OPTION 1 – GALVANIZED STEEL PIPE SCHEDULE 40 – 1½" NOMINAL DIA. ZINC GALVANIZED AT A RATE OF 1.8 OZ/SQUARE FOOT; ASTM A53 TABLE X 2, ATSM, F1083, AND AASHTO M111.
 - B. CORNER END AND PULL POST OPTION 1 – STEEL PIPE SCHEDULE 40 – 2" NOMINAL DIA. ZINC GALVANIZED AT A RATE OF 1.8 OZ/SQUARE FOOT; ASTM A53 TABLE X 2, ATSM, F1083, AND AASHTO M111
 - C. RAIL OPTION 1 – STEEL PIPE SCHEDULE 40 – 1¼" NOMINAL DIA. ZINC GALVANIZED AT A RATE OF 1.8 OZ/SQUARE FOOT; ASTM A53 TABLE X 2, ATSM F1083, AND AASHTO M111.
 - D. CHAIN LINK OPTION 1 (2 INCH MESH WITH TWISTED AND BARBED SELVAGE TOP AND BOTTOM EXCEPT AS DESCRIBED IN NOTE 10 OF THE GENERAL NOTES ON INDEX 802 OF THE 2010 FDOT DESIGN STANDARDS, PAGE 2 OF 3) – AASHTO M181 TYPE 1 ZINC COATED STEEL, NO. 9 GAGE (COATED WIRE DIAMETER) COATED AT THE RATE OF 1.8 OZ/SQUARE FOOT. (M181 CLASS D 2.0 OZ/SQUARE FOOT MODIFIED TO 1.8 OZ/SQUARE FOOT)
 - E. TENSION WIRE OPTIONS 1 – STEEL WIRE NO. 7 ZINC GALVANIZED AT A RATE OF 1.2 OZ/SQUARE FOOT. AASHTO M181
 - F. TIE WIRE AND HOG RING OPTIONS 1 – STEEL WIRE NO. 9 ZINC GALVANIZED AT A RATE OF 1.2 OZ/SQUARE FOOT.
3. BARBED WIRE TOPPING – PER BARBED WIRE ATTACHMENT AS NOTED IN INDEX 802 OF THE 2010 FDOT DESIGN STANDARDS. PAGE 3 OF 3.

JAMES E. VICK, P.E.
FLORIDA LICENSE No.: 39901

REVISIONS						ATKINS 2001 NW 107th Avenue Miami, FL 33172-2507 Certificate of Authorization No. AA 000723	STATE OF FLORIDA DEPARTMENT OF TRANSPORTATION			ELECTRONIC SECURITY GATE CENTRAL REPAIR DEPOT - MP 99 FENCE DETAILS AND NOTES	SHEET NO.
DATE	BY	DESCRIPTION	DATE	BY	DESCRIPTION		ROAD NO.	COUNTY	FINANCIAL PROJECT ID		C-1
							WEST PALM BEACH				

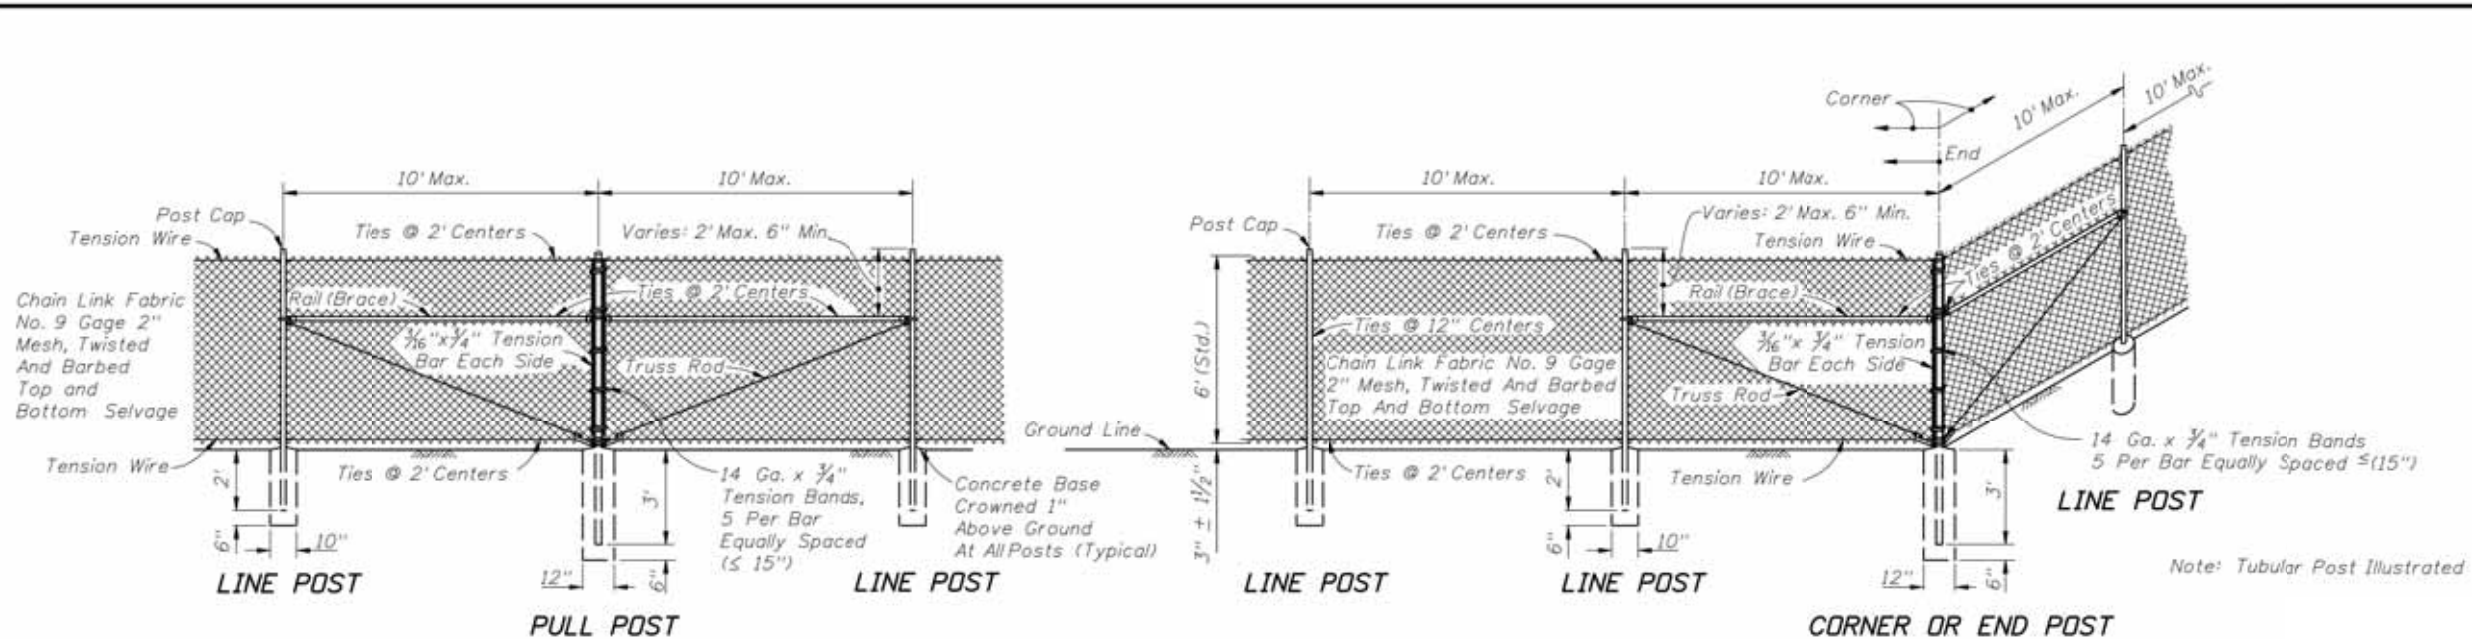

GENERAL NOTES

1. This fence to be used generally in urban areas.
2. For supplemental information refer to Section 550 of FDOT Standard Specifications.
3. Chain link fabric, post, truss rods, tension wires, tie wires, stretcher bars, gates and all miscellaneous fittings and hardware shall meet the requirements of AASHTO and ASTM signify current reference.

4. Fence Component Options:

A. Line post options:

- (1) Galvanized steel pipe, Schedule 40- 1 1/2" nominal dia. zinc galvanized at the rate of 1.8 oz./ft²: ASTM A53 Table X 2, ASTM F1083, and AASHTO M111.
- (2) Aluminum coated steel pipe: ASTM A53, X 2 Tables: Schedule 40- 1 1/2" nominal dia., 1.90" OD: coated at the rate 0.40 oz./ft.: AASHTO M111.
- (3) Aluminum alloy pipe- 2" nominal dia.: ASTM B241 or B221, Alloy 6063, T6.
- (4) Steel H-Beam- 1 1/8" x 1 1/8": Zinc Galv. 1.8 oz./ft.: AASHTO M111 and Detail.
- (5) Aluminum alloy H-Beam- 1 1/8" x 1 1/8" Detail.
- (6) Steel C- 1 1/8" x 1 1/8": Galv.: 1.8 oz./ft. zinc: AASHTO M111: DR, 0.9 oz./ft². zinc-5% aluminum-mischmetal: ASTM F1043 and Detail.
- (7) Resistance welded steel pipe: 50,000 psimin. yield strength ASTM A569/A569M, A653/A653M or undepleted stock of discontinued A446/A446M base materials: ASTM F669 Group IV (Alternative Design): fence industry 2" DD, 1 1/2" NPS, 1.900" dec. equiv., 0.120" min. wall thick. and min. wt. 228 lb./ft.: with ASTM F1043 metric equivalent internal coating Types A, B, C or D and external coating Types A, B, or C: the chromate conversion coating of external Type B shall have a thickness of 15µg/in². min. and the polymer film topcoat shall have a thickness of 0.0003" min.: internal and external coatings are not restricted to the combinations of Table 2, ASTM F1043.

B. Corner, end, and pull post options:

- (1) Galvanized steel pipe, Schedule 40- 2" nominal dia. zinc galvanized at the rate of 1.8 oz./ft²: ASTM A53 Table X 2, ASTM F1083, and AASHTO M111.
- (2) Aluminum coated steel pipe: ASTM A53 steel, X 2 Tables: Schedule 40: 2" nominal dia., 2.375" OD: coated at the rate 0.40 oz./ft.: AASHTO M111.
- (3) Aluminum alloy pipe- 2 1/2" nominal dia.: ASTM B241 or B221, Alloy 6063, T6.
- (4) Resistance welded steel pipe: 50,000 psimin. yield strength ASTM A569/A569M, A653/A653M or undepleted stock of discontinued A446/A446M base materials: ASTM F669 Group IV (Alternative Design): fence industry 2 1/2" DD, 2" NPS, 2.375" dec. equiv., 0.130" min. wall thick. and min. wt. 3.117 lb./ft.: with ASTM F1043 metric equivalent internal coating Types A, B, C or D and external coating Types A, B, or C: the chromate conversion coating of external Type B shall have a thickness of 15µg/in². min. and the polymer film topcoat shall have a thickness of 0.0003" min.: internal and external coatings are not restricted to the combinations of Table 2, ASTM F1043.

C. Rail options:

- (1) Galvanized steel pipe, Schedule 40- 1 1/4" nominal dia. zinc galvanized at the rate of 1.8 oz./ft²: ASTM A53 Table X 2, ASTM F1083, and AASHTO M111.
- (2) Aluminum coated steel pipe: ASTM A53 steel, X 2 Tables Schedule 40: 1 1/4" nominal dia., 1.660" DD: coated at the rate 0.40 oz./ft.: AASHTO M111.
- (3) Aluminum alloy pipe- 1 1/4" nominal dia.: ASTM B241 or B221, Alloy 6063, T6.
- (4) Resistance welded steel pipe: 50,000 psimin. yield strength ASTM A569/A569M, A653/A653M or undepleted stock of discontinued A446/A446M base materials: ASTM F669 Group IV (Alternative Design): fence industry 1 1/8" DD, 1 1/4" NPS, 1.660" dec. equiv., 0.111" min. wall thick. and min. wt. 1.836 lb./ft.: with ASTM F1043 metric equivalent internal coating Types A, B, C or D and external coating Types A, B, or C: the chromate conversion coating of external Type B shall have a thickness of 15µg/in². min. and the polymer film topcoat shall have a thickness of 0.0003" min.: internal and external coatings are not restricted to the combinations of Table 2, ASTM F1043.

D. Chain link fabric options (2" mesh with twisted and barbed selvage top and bottom for all options except as described in Note No. 10):

- (1) AASHTO M181 Type I - Zinc Coated Steel, No. 9 gage (coated wire diameter), coated at the rate of 1.8 oz./ft². (M181 Class D 2.0 oz./ft². modified to 1.8 oz./ft².)
- (2) AASHTO M181 Type II - Aluminum Coated Steel, No. 9 gage (coated wire diameter), coated at the rate of 0.40 oz./ft².
- (3) AASHTO M181 Type IV - Polyvinyl Chloride (PVC) Coated Steel, No. 9 gage (coated core wire diameter), core wire-zinc coated steel. PVC coating: M181 Class A (either extruded or extruded and bonded) or Class B (bonded). See table right. Unless the plans call for M181 standard colors medium green, dark green or black the coating color shall be soft gray matching that of No. 36622 of Federal Standard 595a

E. Tension wire options:

- (1) Steel wire No. 7 gage zinc galvanized at the rate of 1.2 oz./ft²: AASHTO M181.
- (2) Aluminum alloy wire with a diameter of 0.1875" or larger conforming to the requirements of ASTM B211, Alloy 5056 Temper H38, or, Alclad Alloy 5056 Temper H192.
- (3) Aluminum coated steel wire No. 7 gage coated at the rate of 0.040 oz./ft²: AASHTO M181.

F. Tie wire and hog ring operations:

- (1) Steel wire No. 9 gage zinc galvanized at the rate of 1.2 oz./ft².
- (2) Aluminum alloy wire with a diameter of 0.1443" or larger conforming to the requirements of ASTM B211, Alloy 5056 Temper H38, or, Alclad Alloy 5056 Temper H192.
- (3) Aluminum coated steel wire No. 7 gage coated at the rate of 0.040 oz./ft².

	2010 FDOT Design Standards		Last Revision 07/01/09	Sheet No. 1 of 3
	FENCE TYPE B			
	Index No. 802			

REVISIONS						TOLL FACILITIES ENGINEERING FLORIDA'S TURNPIKE ENTERPRISE MILE POST 263 - BUILDING 5319 OC0EE, FLORIDA 34761	STATE OF FLORIDA DEPARTMENT OF TRANSPORTATION			ELECTRONIC SECURITY GATE CENTRAL REPAIR DEPOT - MP 99 FENCE DETAILS AND NOTES	SHEET NO.
DATE	BY	DESCRIPTION	DATE	BY	DESCRIPTION		ROAD NO.	COUNTY	FINANCIAL PROJECT ID		C-2

GENERAL NOTES CONTINUED

5. Unless a specific material is called for in the plans the Contractor may elect to use either a single type of material or a combination of material types from the component options listed in note 4. Combinations of optional materials are restricted as follows:
 - (a) Only one fabric optional material will be permitted between corner and/or end post assemblies.
 - (b) Only one line post optional material will be permitted between corner and/or end post assemblies.
 - (c) Pull post assemblies shall be optional materials identical to either the line post optional material or the corner and end post assembly optional material; but, pull post assemblies shall be the same optional material between any set of corner and/or end post assemblies.
6. Concrete for bases shall be Class NS concrete as specified in Section 347 of the Standard Specifications or a packaged, dry material meeting the requirements of a concrete under ASTM C-387. Materials for Class NS concrete may be proportioned by volume and/or by weight.
7. Line post shall be 8'-6" long (Standard). Line post are to be set in concrete as described above or by the following methods:
 - (a) In accordance with special details and/or as specifically described in the contract plans and specifications.
 - (b) In accordance with ASTM F567 Subsections 5.4 through 5.10 as approved by the Engineer. Line post installed in accordance with Section 5.8 shall be 9'-6" long.
 - (c) Post mounted on concrete structure or solid rock shall be mounted in accordance with the base plate detail "Fence Mounting On Concrete Endwalls And Retaining Wall", Sheet 3; or, by embedment in accordance with ASTM F567 Subsection 5.5.

End, pull and corner post assemblies shall be in concrete as detailed above for all soil conditions other than solid rock. Post within assemblies that are located on concrete structures or solid rock shall be set by base plate or by embedment as prescribed under (b) above for line post.

Line and assembly post set in concrete bases shall be set an additional 3" in depth for each 1' of fence height greater than 6'.
8. Pull post shall be used at breaks in vertical grades of 15° or more, or at approximately 350' centers except that this maximum interval may be reduced by the Engineer on curves where the curve is greater than 3°.
9. Corner post are to be installed at all horizontal breaks in fence at 15° or more and as required at vertical breaks over 15° as determined by the Engineer.
10. When fence has an installed top of fabric height less than 6' knuckled top and bottom selvages shall be used unless the plans specifically identify locations for twisted selvage fabrics.
11. Unless sliding gates or special gates are called for in the plans, all gates shall be chain link swing gates meeting the material requirements described and as approved by the Engineer. Payment shall include the gates, single or double, all necessary hardware for installation and any additional length and/or size for posts at the opening. Gates shall be paid for under the contract unit price for Fence Gates, EA.
12. For construction purposes corner post assemblies shall consist of one corner post, two braces, two truss rods, and all necessary fittings and hardware as detailed. End post assemblies shall consist of one end post, one brace, one truss rod and all necessary fittings and hardware as detailed.
13. All post, tension wires, chain link fabric, tie wires, Class NS concrete, and all miscellaneous fittings and hardware to be included in the cost for Fencing, LF.


TYPE IV VINYL COATED FABRIC								
AASHTO M181 Table 4 Redefined As Follows								
Specified Diameter Of Metallic Coated Core Wire		Minimum Weight Of Zinc Coating		PVC Thickness Range				
				M181 Class A (Extruded Or Extruded And Bonded Coating)		M181 Class B (Bonded Coating)		
in.	mm	gage	oz./ft ²	g/m ²	in.	mm	in.	mm
0.148	3.77	9	0.30	92	0.015 to 0.025	0.38 to 0.64	0.006 to 0.010	0.15 to 0.25

DESIGN NOTE

This index details fencing that is constructed with chain link fabric 6' (nominal) in height and with specific ground clearance. For fencing of different height or installation details, the fence shall be fully detailed in the Contract plans.


	2010 FDOT Design Standards		Last Revision 07/01/09	Sheet No. 2 of 3
	FENCE TYPE B			
	Index No. 802			

REVISIONS						TOLL FACILITIES ENGINEERING <small>FLORIDA'S TURNPIKE ENTERPRISE MILE POST 263 - BUILDING 5319 OC0EE, FLORIDA 34761</small>	STATE OF FLORIDA DEPARTMENT OF TRANSPORTATION			ELECTRONIC SECURITY GATE CENTRAL REPAIR DEPOT - MP 99 FENCE DETAILS AND NOTES	SHEET NO.
DATE	BY	DESCRIPTION	DATE	BY	DESCRIPTION		ROAD NO.	COUNTY	FINANCIAL PROJECT ID		C-3
								WEST PALM BEACH			

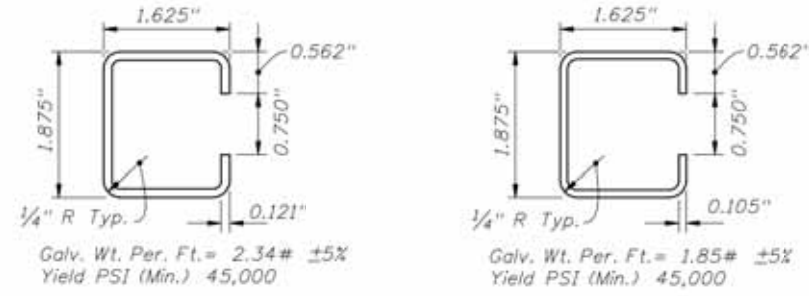


STANDARD WALL THINWALL

OPTIONAL "C" LINE POST

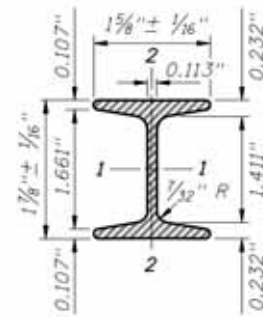


	STEEL		ALUMINUM	
Area (Sq. In.)	724		724	
Weight (Lb./Ft.)	2.72 ± 5% (Galv.)		0.91 ± 5%	
Surface Area (SF/Ft.)	0.776		0.776	
Tensile Strength (psi Min.)	80,000		30,000	
Yielding Point (psi Min.)	48,000		25,000	
	Axes		Axes	
	1-1	2-2	1-1	2-2
Moment Of Inertia	0.428	0.101	0.428	0.101
Section Modulus	0.456	0.124	0.456	0.124
Rad. Of Gyration	0.779	0.373	0.779	0.373

OPTIONAL 1 1/8" x 1 1/8" H-BEAM LINE POST

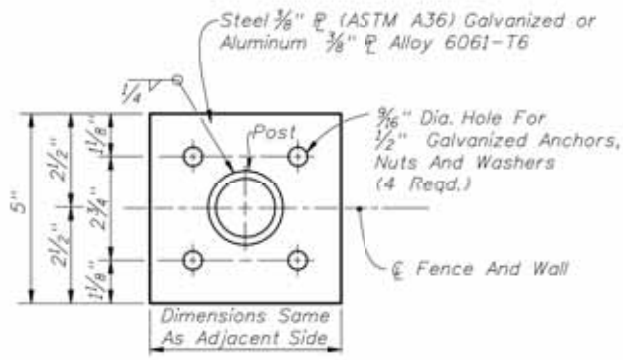


TOP VIEW FOUR ANCHOR PLATE OPTION

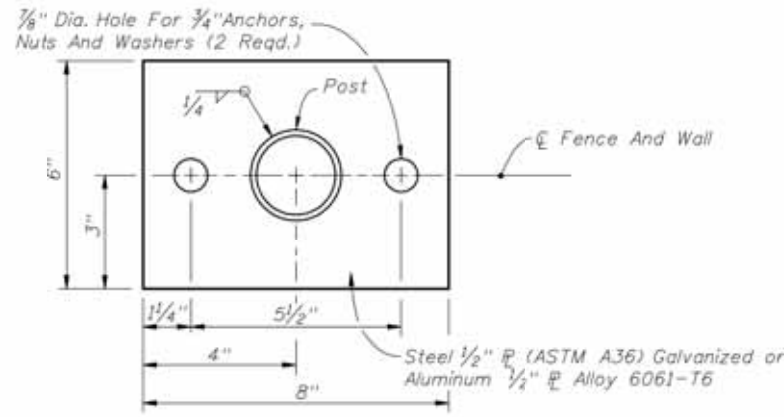


TOP VIEW TWO ANCHOR PLATE OPTION

FENCE MOUNTING ON CONCRETE ENDWALL AND RETAINING WALLS

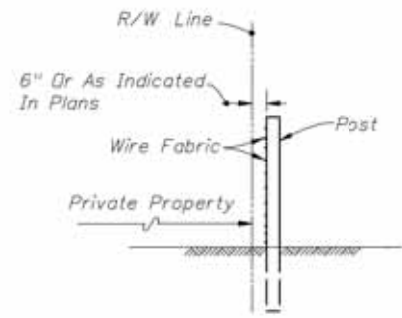

FENCE POSITION AT LOCATIONS WITHOUT FRONTAGE ROADS

(REFER TO DETAIL PLANS FOR FENCE POSITION AT LOCATIONS WITH FRONTAGE ROADS)

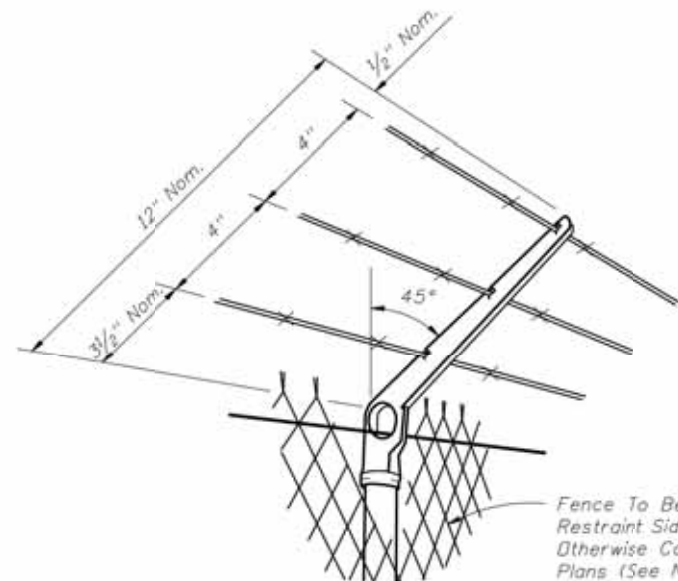

NOTES

- Attachments to be used only when called for in the plans. Attachments to extend in direction of restraint. Unless otherwise called for in plans, direction of restraint will be as follows:
- Outward on limited access right of way line.
 - Outward on controlled access right of way line.
 - Outward from utilities and hazardous facilities located within highway right of way.
 - Outward from lateral ditches, outfalls, retention basins, canals, borrow areas and similar support facilities.
 - Inward on pedestrian ways.
- The cap-arm shall be designed to provide a drive fit over the top of posts and to exclude moisture in posts with tubular sections.

BARB WIRE ATTACHMENT

BASE PLATE AND ANCHOR NOTES:

- Base plate identical for line, pull, end and corner posts and shall be considered an integral part of the respective posts for basis of payment.
- Post to be plumbed by gravel shim under base plate.
- Anchors (Galvanized Steel):
 - 12" Cast In Place, 10 1/2" Embedment: Headed Bolts, U-Bolts or Cluster Plates.
 - 8" Adhesive Anchors, 6" Min. Embedment.*
 - *Adhesive anchors shall be headless anchor bolts set in drilled holes with an Adhesive Material System in accordance with Specification Sections 416 and 937; drilled holes shall be 1/8" larger in diameter than the anchor bolt. Expansion Bolts Not Permitted.



2010 FDOT Design Standards

FENCE TYPE B

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REVISIONS					
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TOLL FACILITIES ENGINEERING


FLORIDA'S TURNPIKE ENTERPRISE
MILE POST 263 - BUILDING 5319
OCOE, FLORIDA 34761

STATE OF FLORIDA DEPARTMENT OF TRANSPORTATION

ROAD NO.	COUNTY	FINANCIAL PROJECT ID
	WEST PALM BEACH	

ELECTRONIC SECURITY GATE
CENTRAL REPAIR DEPOT- MP99
FENCE DETAILS AND NOTES

SHEET NO.
C-4


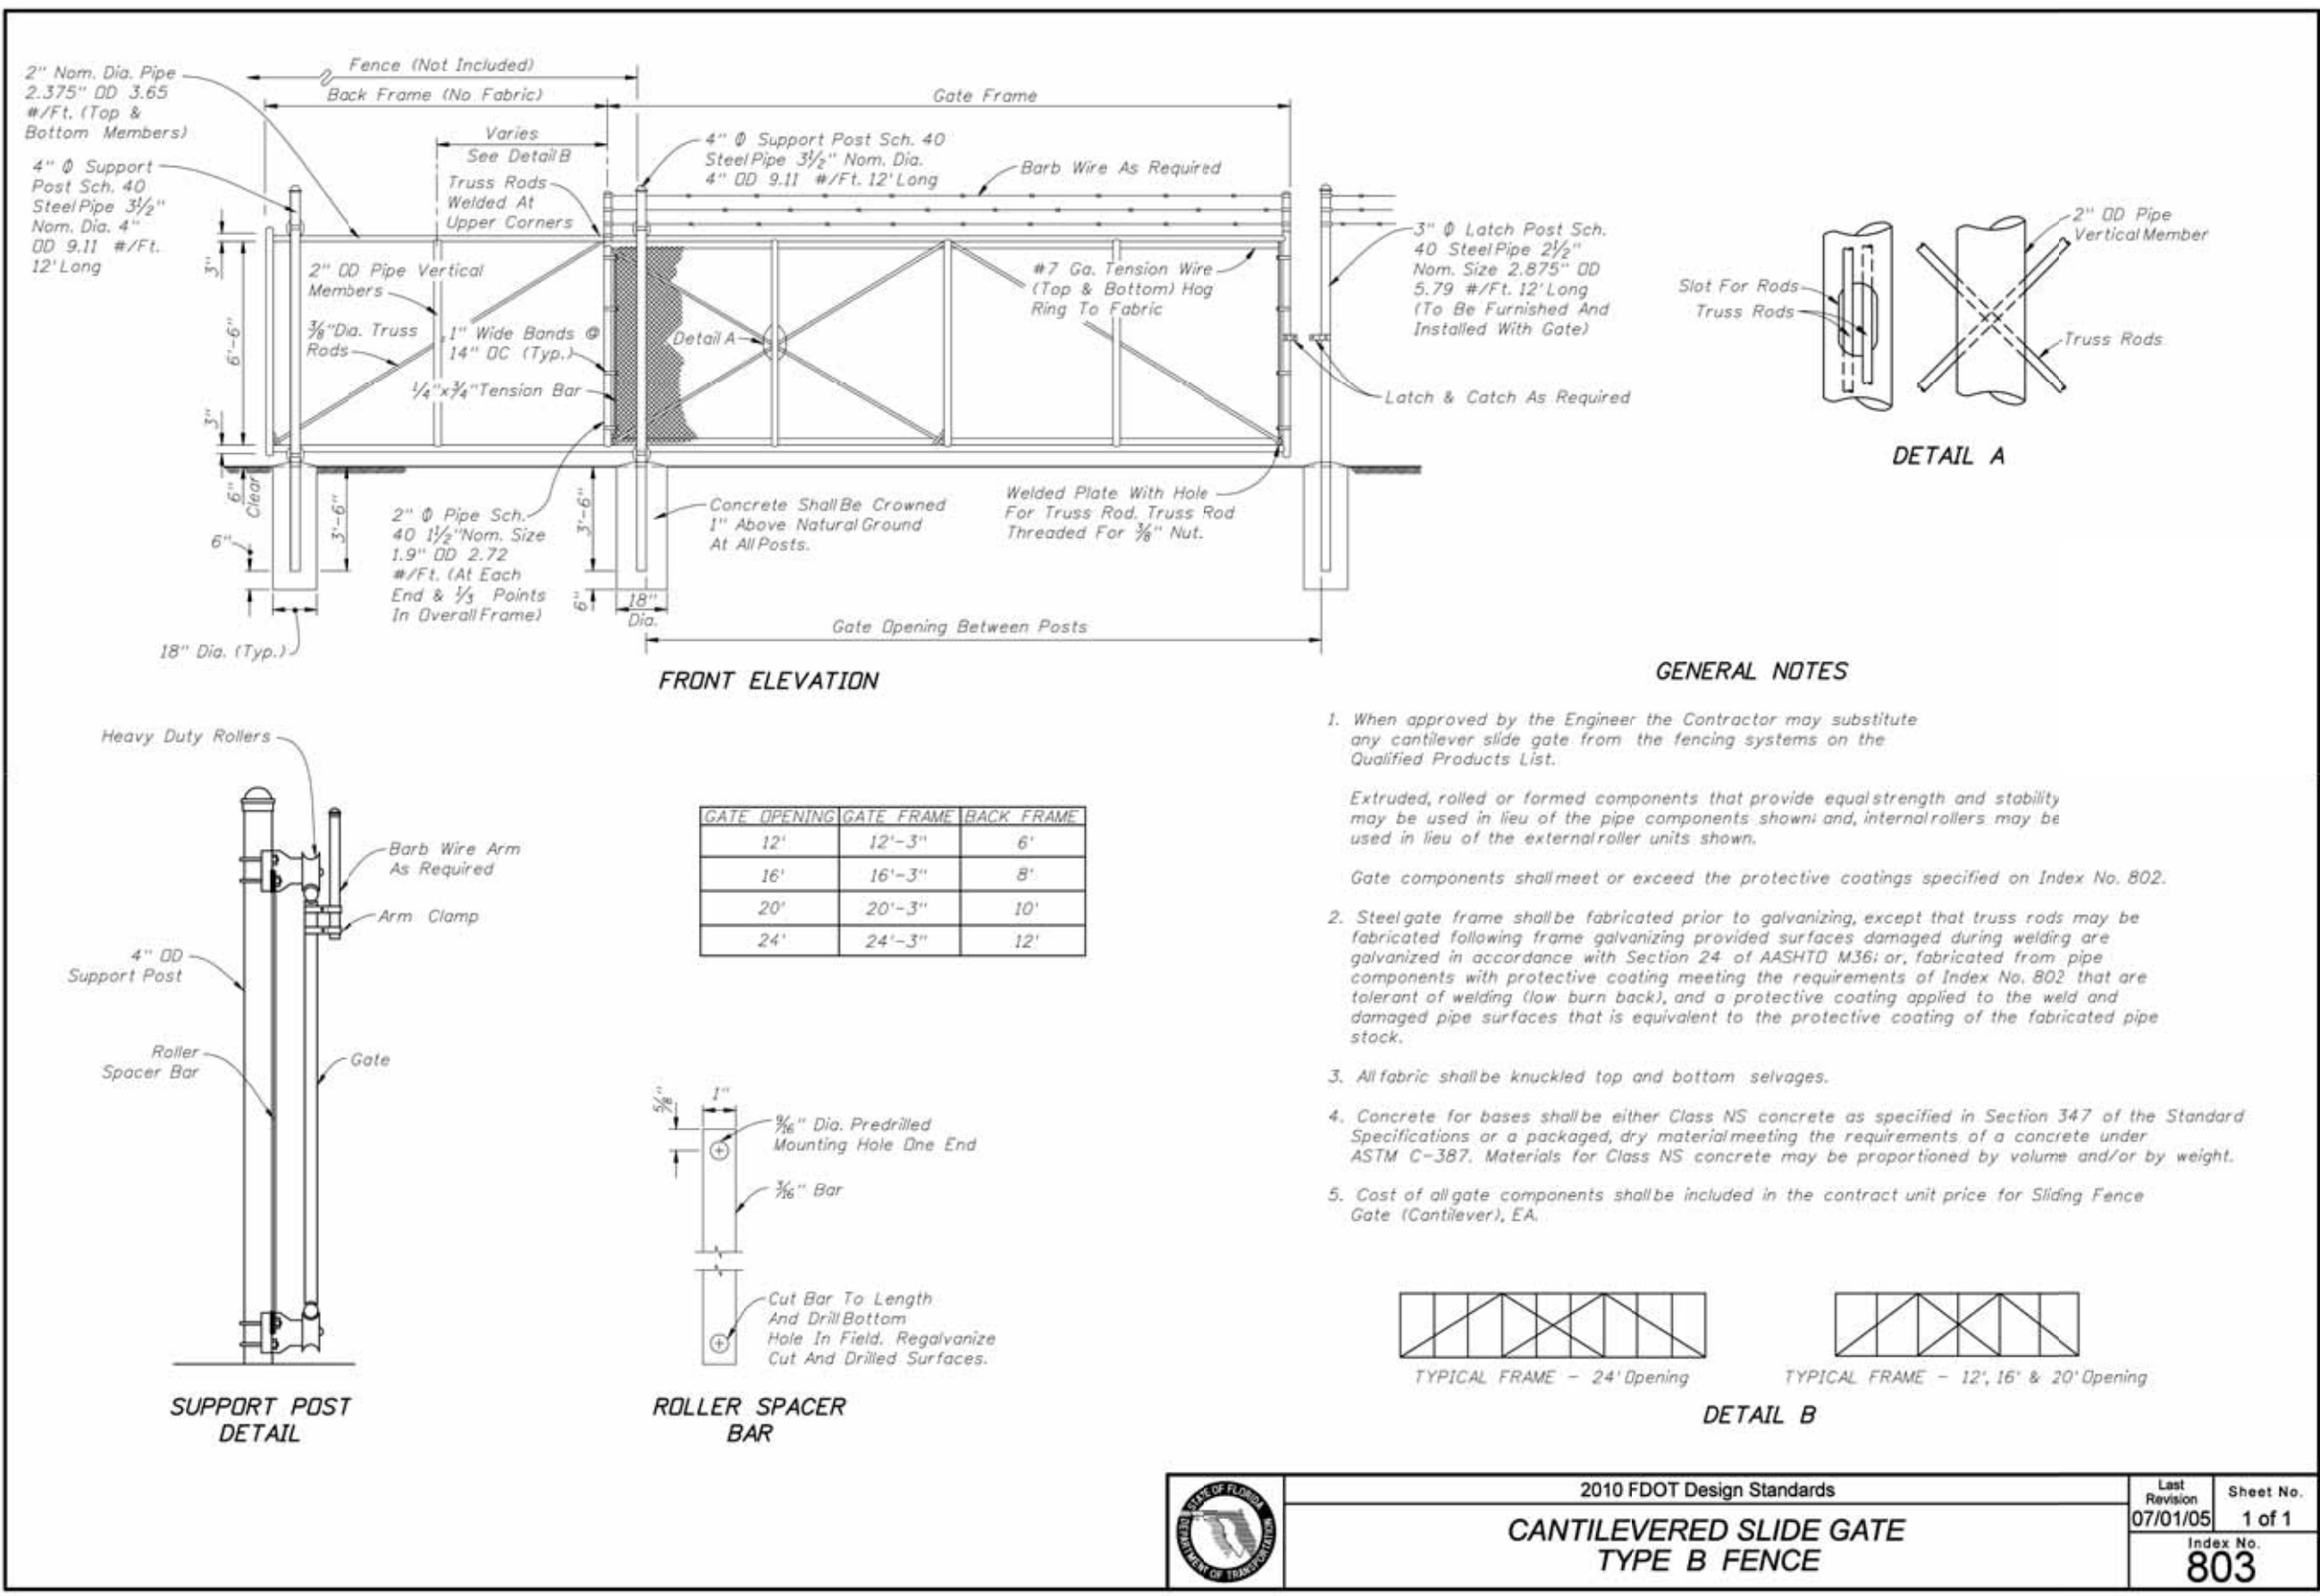


REVISIONS						TOLL FACILITIES ENGINEERING	STATE OF FLORIDA DEPARTMENT OF TRANSPORTATION			ELECTRONIC SECURITY GATE CENTRAL REPAIR DEPOT - MP 99 FENCE DETAILS AND NOTES	SHEET NO. C-5
DATE	BY	DESCRIPTION	DATE	BY	DESCRIPTION		ROAD NO.	COUNTY	FINANCIAL PROJECT ID		
						FLORIDA'S TURNPIKE ENTERPRISE MILE POST 263 - BUILDING 5319 OC0EE, FLORIDA 34761		WEST PALM BEACH			

GATE NOTES:

NOTES APPLICABLE TO THIS PROJECT:

1. SPECIFICATIONS GOVERNING THE GATE IS SECTION 550 OF THE FLORIDA DEPARTMENT OF TRANSPORTATION STANDARD SPECIFICATIONS FOR ROAD AND BRIDGE CONSTRUCTION 2010 EDITION AND INDEX 803 OF THE 2010 FDOT DESIGN STANDARDS

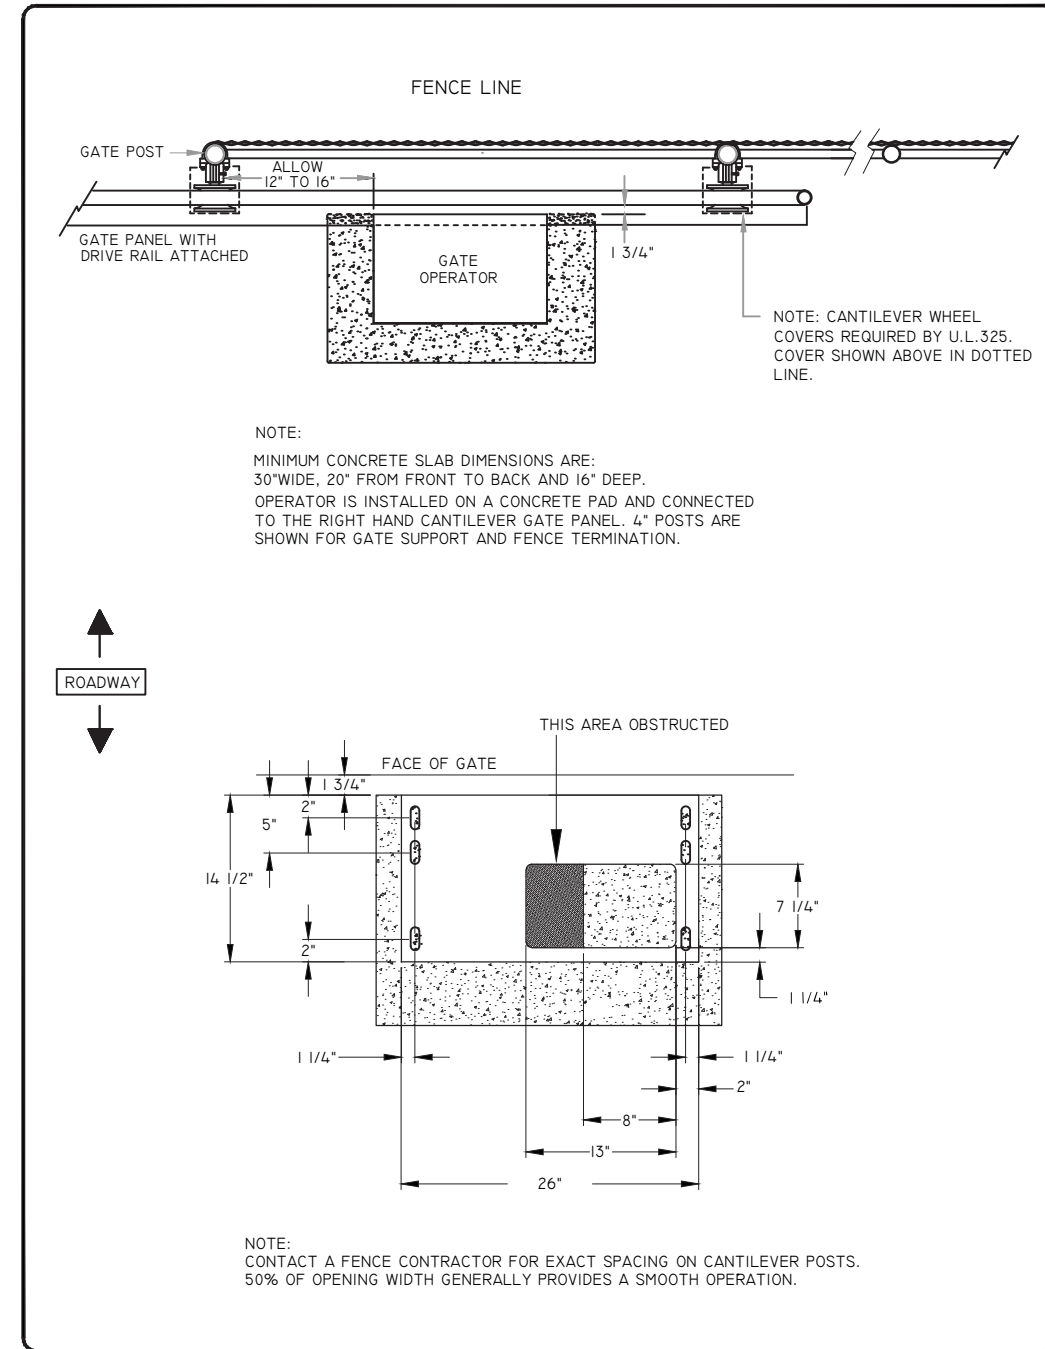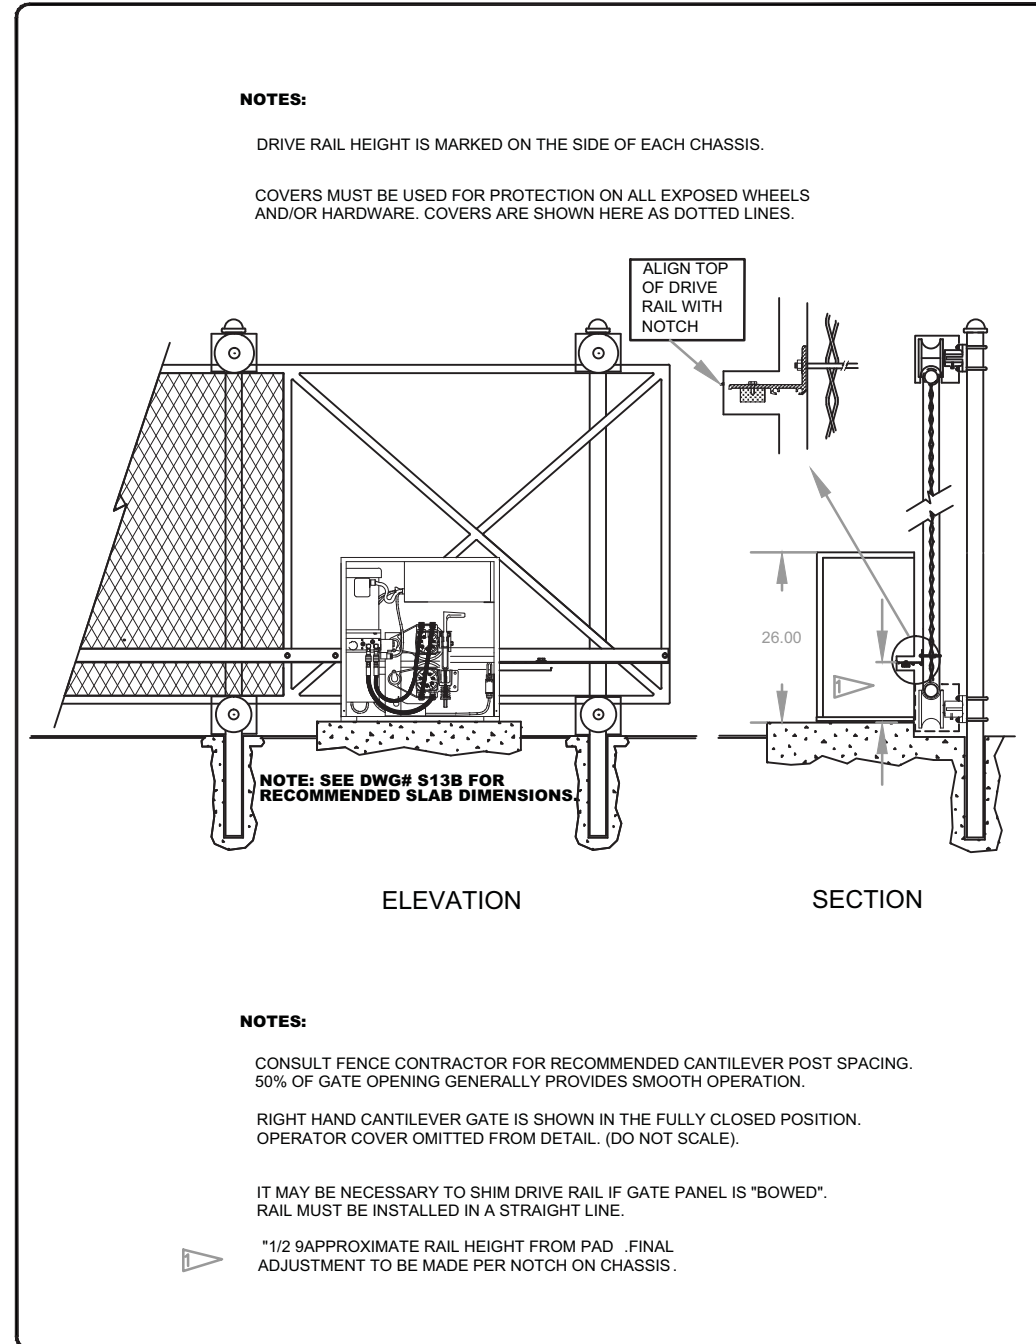

	TITLE	DRAWN	DATE	THIRD ANGLE PROJECTION	REV
	Slide Gate Operator (typ) R.H. Cantilever Gate Panel	KW	11/11/08		D
		CHECKED	DATE	PART NUMBER	
		SHOP	MM/YY/DD	N/A	
		APPROVED	DATE	DRAWING NUMBER:	SHT OF
	ENGRNG	MM/YY/DD	S13A	1 OF 1	

	TITLE	DRAWN	DATE	THIRD ANGLE PROJECTION	REV
	Slide Gate Operator (typ) R.H. Cantilever Gate Panel	RP	2/21/08		B
		CHECKED	DATE	PART NUMBER	
		SHOP	MM/YY/DD	N/A	
		APPROVED	DATE	DRAWING NUMBER:	SHT OF
	ENGRNG	MM/YY/DD	S13B	1 OF 1	

<p>REVISIONS</p> <table border="1"> <thead> <tr> <th>DATE</th> <th>BY</th> <th>DESCRIPTION</th> <th>DATE</th> <th>BY</th> <th>DESCRIPTION</th> </tr> </thead> <tbody> <tr> <td> </td> <td> </td> <td> </td> <td> </td> <td> </td> <td> </td> </tr> </tbody> </table>						DATE	BY	DESCRIPTION	DATE	BY	DESCRIPTION							<p>TOLL FACILITIES ENGINEERING</p> <p>FLORIDA'S TURNPIKE ENTERPRISE MILE POST 263 - BUILDING 5319 OC0EE, FLORIDA 34761</p>		<p>STATE OF FLORIDA DEPARTMENT OF TRANSPORTATION</p> <table border="1"> <tr> <th>ROAD NO.</th> <th>COUNTY</th> <th>FINANCIAL PROJECT ID</th> </tr> <tr> <td> </td> <td>WEST PALM BEACH</td> <td> </td> </tr> </table>		ROAD NO.	COUNTY	FINANCIAL PROJECT ID		WEST PALM BEACH		<p>ELECTRONIC SECURITY GATE CENTRAL REPAIR DEPOT- MP99 GATE OPERATOR DETAILS</p>		<p>SHEET NO.</p> <p>C-6</p>
DATE	BY	DESCRIPTION	DATE	BY	DESCRIPTION																									
ROAD NO.	COUNTY	FINANCIAL PROJECT ID																												
	WEST PALM BEACH																													


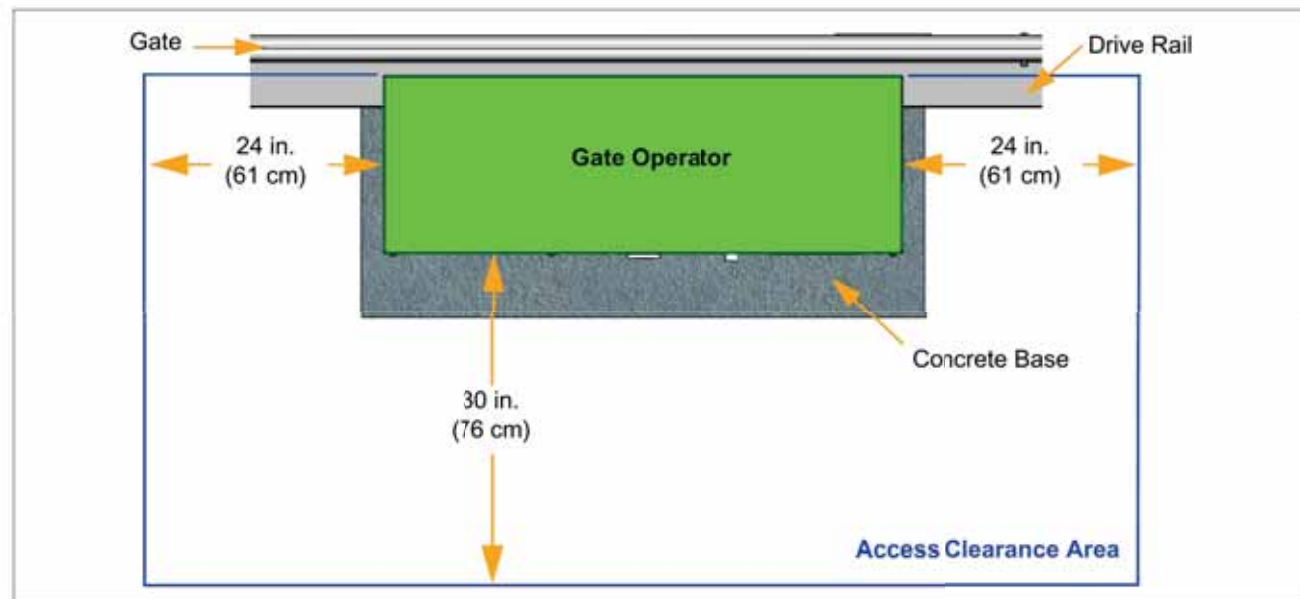


Figure 2-2. Clearance Requirements - SlideDriver 30F

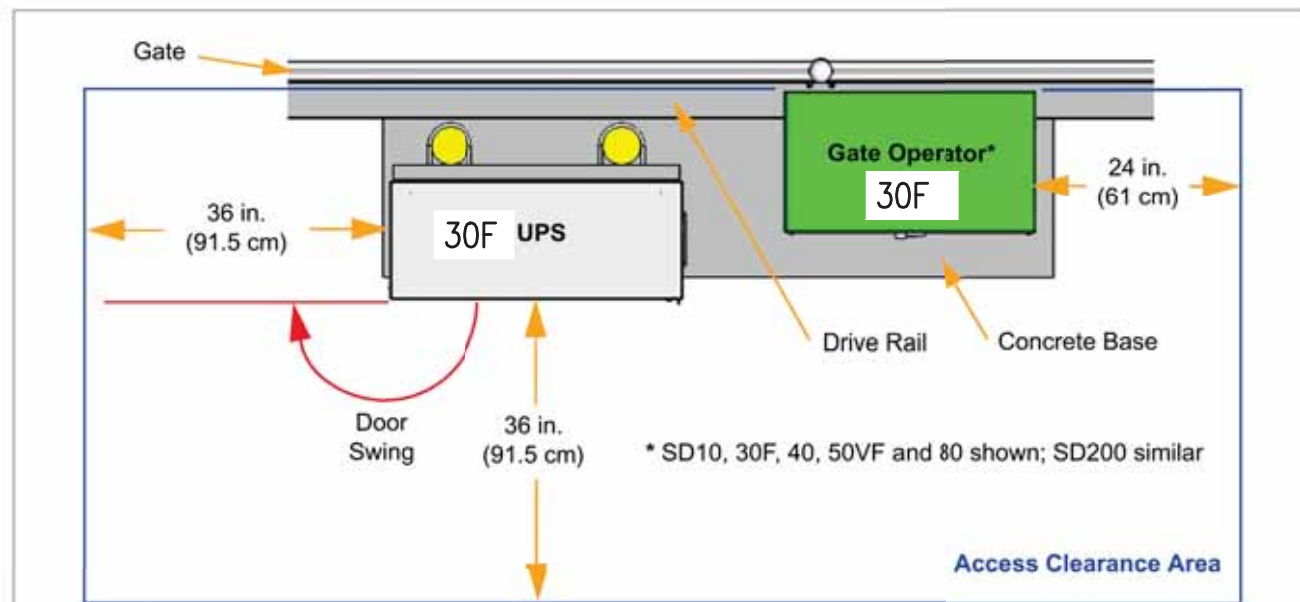

Note: If the UPS is located remote from the Gate Operator, then:

- a. The access clearance requirements for the left-side and front of the UPS are as shown above but the right-side access clearance is 18 in. (45.7 cm). Also, a minimum of 24 in. (61 cm) for rear access is recommended.

CLEARANCE REQUIREMENTS – 30F UPS OPTION

LTR	DESCRIPTION	DATE	APPRVD
A	INITIAL RELEASE	-	-

TOP VIEW

FRONT VIEW

SIDE VIEW

NOTE: ENCLOSURE SIZE IS 30" WIDE, 42" HIGH AND 12" DEEP. STANDARD ENCLOSURE IS "NEMA 3R" PUMP PANEL TO BE LOCATED WITHIN 100 FEET OF GATE OPERATOR.

NOTE: SUPPORT POSTS, STRUT CHANNELS AND "U" BOLTS ARE NOT FURNISHED BY HY-SECURITY GATE OPERATORS.

NOTE: DRAWING IS NOT TO SCALE.


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	30F UPS	KERI	06/15/00	G39	A
	PACKAGE ENCLOSURE	CHECKED	DATE	THIRD ANGLE PROJECTION	SHT 1 OF 1
		APPROVED	DATE		

GATE NOTES:

NOTES APPLICABLE TO THIS PROJECT:

1. SPECIFICATIONS GOVERNING THE GATE IS SECTION 550 OF THE FLORIDA DEPARTMENT OF TRANSPORTATION STANDARD SPECIFICATIONS FOR ROAD AND BRIDGE CONSTRUCTION 2010 EDITION AND INDEX 803 OF THE 2010 FDOT DESIGN STANDARDS

REVISIONS						TOLL FACILITIES ENGINEERING <small>FLORIDA'S TURNPIKE ENTERPRISE MILE POST 263 – BUILDING 5319 OCOE, FLORIDA 34761</small>	STATE OF FLORIDA DEPARTMENT OF TRANSPORTATION			ELECTRONIC SECURITY GATE CENTRAL REPAIR DEPOT- MP99 REMOTE UPS ENCLOSURE DETAILS	SHEET NO.
DATE	BY	DESCRIPTION	DATE	BY	DESCRIPTION		ROAD NO.	COUNTY	FINANCIAL PROJECT ID		C-7

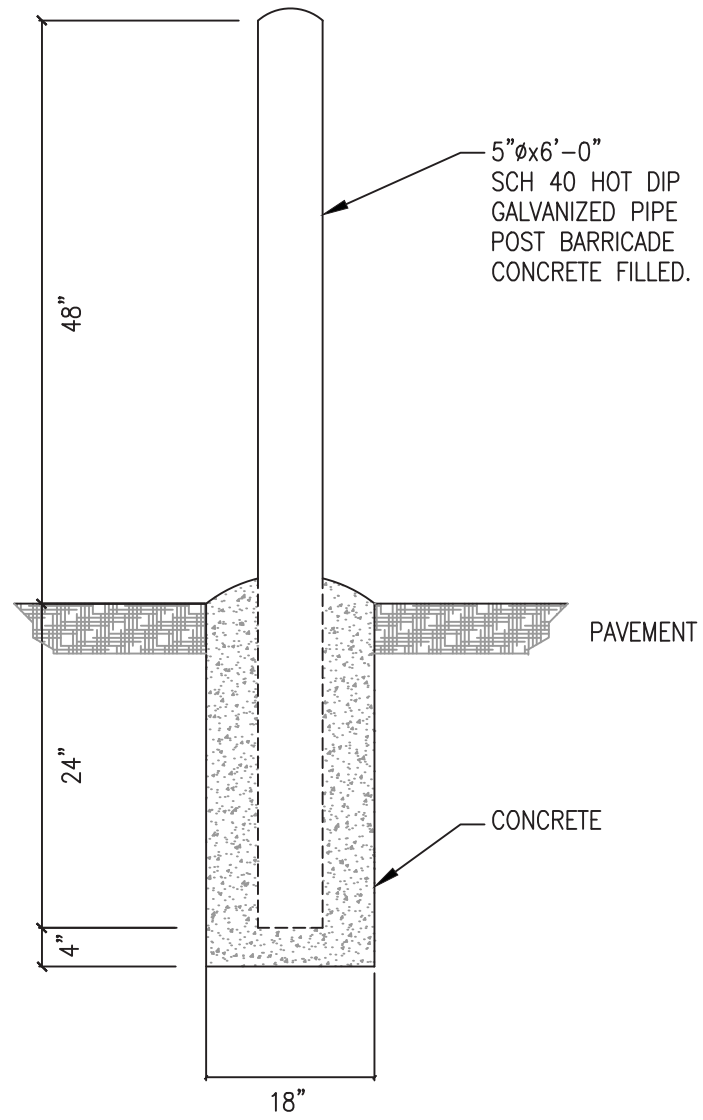

NOTES:

- POST BARRICADES SHALL BE PAINTED WITH ONE PRIME COAT OF RED OXIDE PRIMER AND THEN ONE FINISH COAT OF SAFETY YELLOW ENAMEL PAINT.

1 BOLLARD DETAIL
NTS



2 ACCESS CONTROL STATION
NTS

JAMES E. VICK, P.E.
FLORIDA LICENSE No.: 39901

REVISIONS						ATKINS 2001 NW 107th Avenue Miami, FL 33172-2507 Certificate of Authorization No. AA 000723	STATE OF FLORIDA DEPARTMENT OF TRANSPORTATION			ELECTRONIC SECURITY GATE CENTRAL REPAIR DEPOT- MP99 BOLLARD DETAIL	SHEET NO.
DATE	BY	DESCRIPTION	DATE	BY	DESCRIPTION		ROAD NO.	COUNTY	FINANCIAL PROJECT ID		C-8
								WEST PALM BEACH			